

Memorandum to the City of Markham Committee of Adjustment

March 4, 2019

File: A/112/17
Address: 104 Glen Cameron Road, Thornhill
Applicant: Ron Pansino
Owners: Kiril Penkov & Teodora Buhteva
Hearing Date: March 13, 2019

Further to our previous comments provided to the Committee of Adjustment for the September 13, 2017 Hearing (see Attachment 1), the following revised comments are provided on behalf of the West Team:

The applicant is requesting relief from the requirements of By-law 2237, as amended to permit:

- a) **Section 4.1:**
a second dwelling unit, whereas the By-law permits no more than one single detached dwelling on one lot;
- b) **Infill By-law 101-90, Section 1.2 (i):**
a maximum building height of 9.22 m (30.24 ft.); whereas the By-law permits a maximum building height of 8.6 m (28.2 ft.);
- c) **Amending By-law 61-94, Section 4:**
a minimum east side yard setback of 1.3 m (4.26 ft.); whereas the By-law requires a minimum side yard setback of 1.8 m (5.9 ft.);
- d) **Amending By-law 61-94, Section 4:**
a minimum west side yard setback of 0.27 m (0.88 ft.), to an existing one storey carport, whereas the By-law requires a side yard setback of 1.2 m (3.9 ft.);

The requested variances relate to an addition to the existing dwelling.

COMMENTS

This application was deferred sine die at the September 13, 2017 to provide the applicant an opportunity to confirm with Zoning staff whether any additional variances were required, including, to permit a "Second Dwelling Unit", and re-circulate / re-notify the application, if required. A Zoning Preliminary review (file no. ZPR 17 176805) was completed on May 2, 2018 to confirm the required variances as noted above.

Planning Staff have reviewed the revised application with respect to Section 45(1) of The Planning Act, R.S.O. 1990, c. P.13, as amended, and have no concerns with this application. However, the onus is ultimately on the applicant to demonstrate why they should be granted relief from the requirements of the zoning by-law, and how they satisfy the tests of the Planning Act required for the granting of minor variances.

Should the Committee see merit in approving the revised application as requested, it is recommended that the conditions provided in Appendix "A" be attached to any approval of this application.

PREPARED BY:

Rick Cefaratti, Planner, West District

REVIEWED BY:

David Miller, West District Manager

APPENDIX "A"**CONDITIONS TO BE ATTACHED TO ANY APPROVAL OF FILE A/112/17**

1. The variances apply only to the proposed development as long as it remains;
2. That the variances apply only to the subject development, in substantial conformity with the plan(s) attached as 'Appendix A' to this Staff Report, and that the Secretary-Treasurer receive written confirmation from the Director of Planning and Urban Design or designate that this condition has been fulfilled to his or her satisfaction.
3. Submission of a Tree Assessment and Preservation Plan, prepared by a qualified arborist in accordance with the City's Streetscape Manual (2009), as amended, to be reviewed and approved by the City, and that the Secretary-Treasurer receive written confirmation from the Director of Planning and Urban Design or designate that this condition has been fulfilled to his/her satisfaction, and that any detailed Siting, Lot Grading and Servicing Plan required as a condition of approval reflects the Tree Assessment and Preservation Plan;
4. That prior to the commencement of construction or demolition, tree protection be erected and maintained around all trees on site in accordance with the City's Streetscape Manual, including street trees, in accordance with the City's Streetscape Manual (2009) as amended, and inspected by City Staff to the satisfaction of the Director of Planning and Urban Design or their designate;
5. That tree replacements be provided and/or tree replacement fees be paid to the City if required in accordance with the Tree Assessment and Preservation Plan, and that the Secretary-Treasurer receive written confirmation that this condition has been fulfilled to the satisfaction of the Director of Planning and Urban Design or designate.
6. That the reduced west side yard setback of 0.27 m (0.88 ft.) only applies to allow an unenclosed carport with no walls.
7. Submission and approval of a siting / grading plan of the property, and that the Secretary-Treasurer receive written confirmation that this condition has been fulfilled to the satisfaction of the Director of Engineering or designate;
8. That subject to the review and approval of a siting/grading plan, the owner demonstrate that there is no negative impact along any abutting property respecting surface water drainage, and that the Secretary-Treasurer receive written confirmation that this condition has been fulfilled to the satisfaction of the Director of Engineering or designate;

CONDITIONS PREPARED BY:



Rick Cefaratti, MCIP, RPP, Planner II, West District

File Path: Amanda\File\17 171072\Documents\District Team Short Report Memo

2. EXISTING BUILDINGS

STEEL BEAMS AND COLUMNS SHALL BE SHIPPED PREMIUM.
STEEL BEAMS AND COLUMNS SHALL BE SHIPPED PREMIUM.

THE CALCULATIONS FOR UNPROTECTED OPENINGS WITH CHANGES INDICATED AS FOLLOWS:

SOUTH SIDE:
LIMITING DISTANCE 8' 7" M.
SOUTH SIDE EXPOSING BUILDING FACE AREA: 50.49x42 = 100%
SOUTH SIDE OPENINGS AREA: 10 AND
PROPOSED 21%. UNPROTECTED OPENINGS, WHILE OBC ALLOWS 90% (3.2.3.1.B)

NORTH SIDE:
LIMITING DISTANCE 17' 7" M.
NORTH SIDE EXPOSING BUILDING FACE AREA: 58.78x42 = 100%
NORTH SIDE OPENINGS AREA: 9.342
PROPOSED 15.86%. UNPROTECTED OPENINGS, WHILE OBC ALLOWS 100% (3.2.3.1.B)

WEST SIDE:
LIMITING DISTANCE 4' M.
WEST SIDE EXPOSING BUILDING FACE AREA: 11.112
WEST SIDE OPENINGS AREA: 11.112
PROPOSED 4% UNPROTECTED OPENINGS, WHILE OBC ALLOWS 11.08% (3.2.3.1.B)

EAST SIDE:
LIMITING DISTANCE 15' 5" M.
EAST SIDE EXPOSING BUILDING FACE AREA: 71.442
EAST SIDE OPENINGS AREA: 13.142
UNPROTECTED OPENINGS AREA ON EAST SIDE: 13.142
PROPOSED 14% UNPROTECTED OPENINGS, WHILE OBC ALLOWS 6.1% (3.2.3.1.B)

ALL FOUNDATION WALLS SHALL BE REINFORCED WITH 4#10 REBAR.

FOUNDATIONS ARE TO BE PROVIDED CONCRETE OR DRIED
REFINED GRANULAR, THE THICKNESS OF THE FOUNDATION WALL SCHEDULE FOR TYPE AND
THICKNESS.

CALCIFICATIONS SHALL BE HEAVY COAT OF BITUMEN 305 MATERIAL.
FOUNDATION WALL TO EXTEND UPWARD 12" (300MM) ABOVE
GRADE.

A DRAINED AREA SHALL BE PROVIDED ON THE OUTSIDE OF A
FOUNDATION WALL, WHERE THE INTERFACED MATERIAL IS EXPOSED.
LEVEE SLAB (IT IS BELOW EXTERIOR GRADE) THE DRAINED AREA
SHALL CONSIST OF DELTA CEE AND MANUFACTURED BY CORSELLA
DOORLINE ON ELEVATOR.

FOUNDATION WALLS SHALL BE BRACED OR HAVE THE FLOOR JOISTS
INSTALLED BEFORE EACH STAGING.

WINDOWS CALCULATIONS

SITE PLAN CALCULATIONS AS FOLLOWS:

ALLOWED MAXIMUM LOT COVERAGE 33.0% OR 2.31SF
LOT COVERAGE 32.7% OR 2.26SF
CALCULATIONS AS FOLLOWS:
1. HOUSE 1.88SF
2. SHED 2.88SF
3. CARPORT 1.68SF
TOTAL: 2.00SF
MAXIMUM NEW ROOF HEIGHT FROM THE MIDDLE OF THE ROAD: 6.5M

SITE CALCULATIONS

1:1

WALL TYPE LEGEND

EXISTING WALLS
NEW WALLS
DEMOLISHED

WALL TYPE LEGEND

W1 LATH AND PLASTER FINISH TO MATCH EXISTING
NEW
W2
W3
DEMOLISHED

FLOOR TYPE LEGEND

F1
F2

DOOR AND WINDOW TYPE LEGEND

D1
D2

FOUNDATION - DEMO

1 1:75

FOUNDATION PROPOSED

3 1:75



A102

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PLEKS

Architectural Services
Project Services


TO CLIENT FROM
Drew Engineering
EAST GEORGIA &
FOUNDED PROPOSED
JACK SP

Date 05/05/16
Drawing No. 175
Dwgt 100





TBM
Engineering Inc.
Professional Services

113 Atlantic Center Dr.
Woodstock, GA (404) 994-2970
www.tbme.com
info@tbme.com

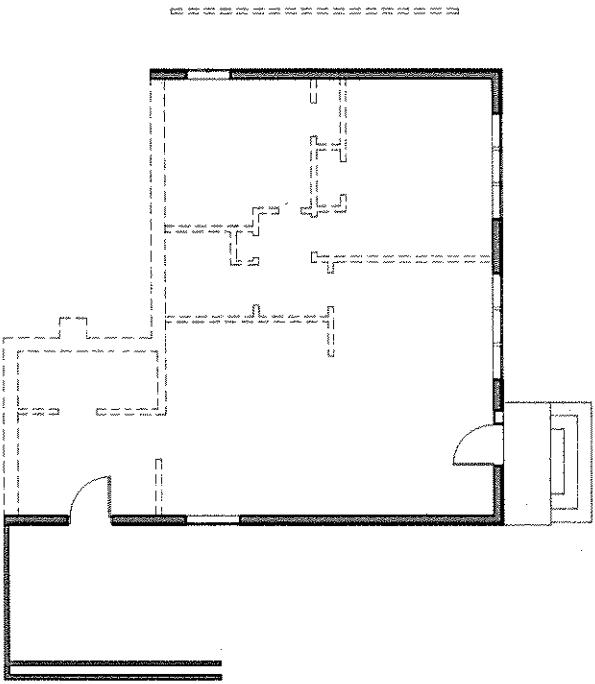


1ST FLOOR - DEMO
2 1:75

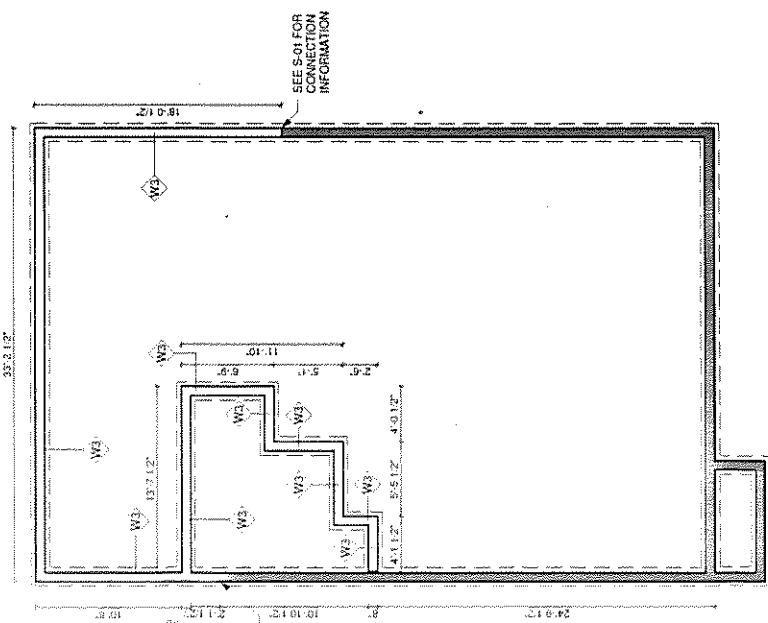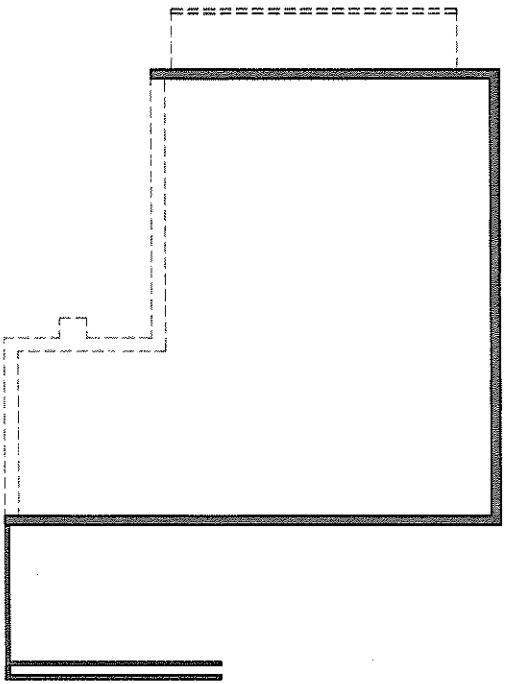

SEE S-01 FOR
CONNECTION
INFORMATION



TUM Engineers Inc.
33 Astoria Lane Dr.
St. Paul, MN 55113 (651) 697-2474

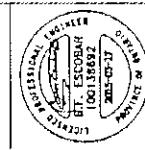

PLEKS

WIRING SERVICES

**PROPOSED FIRST &
SECOND FLOOR
PLANS**

DDU-175


PROPOSED - 2ND EDITION

PRO
1 : 75

PROPOSED - 1ST FLOOR

2

GENERAL NOTE
PROPOSED LINES FOR EXTERIOR OPENINGS; REFER TO S-2 & S-3.

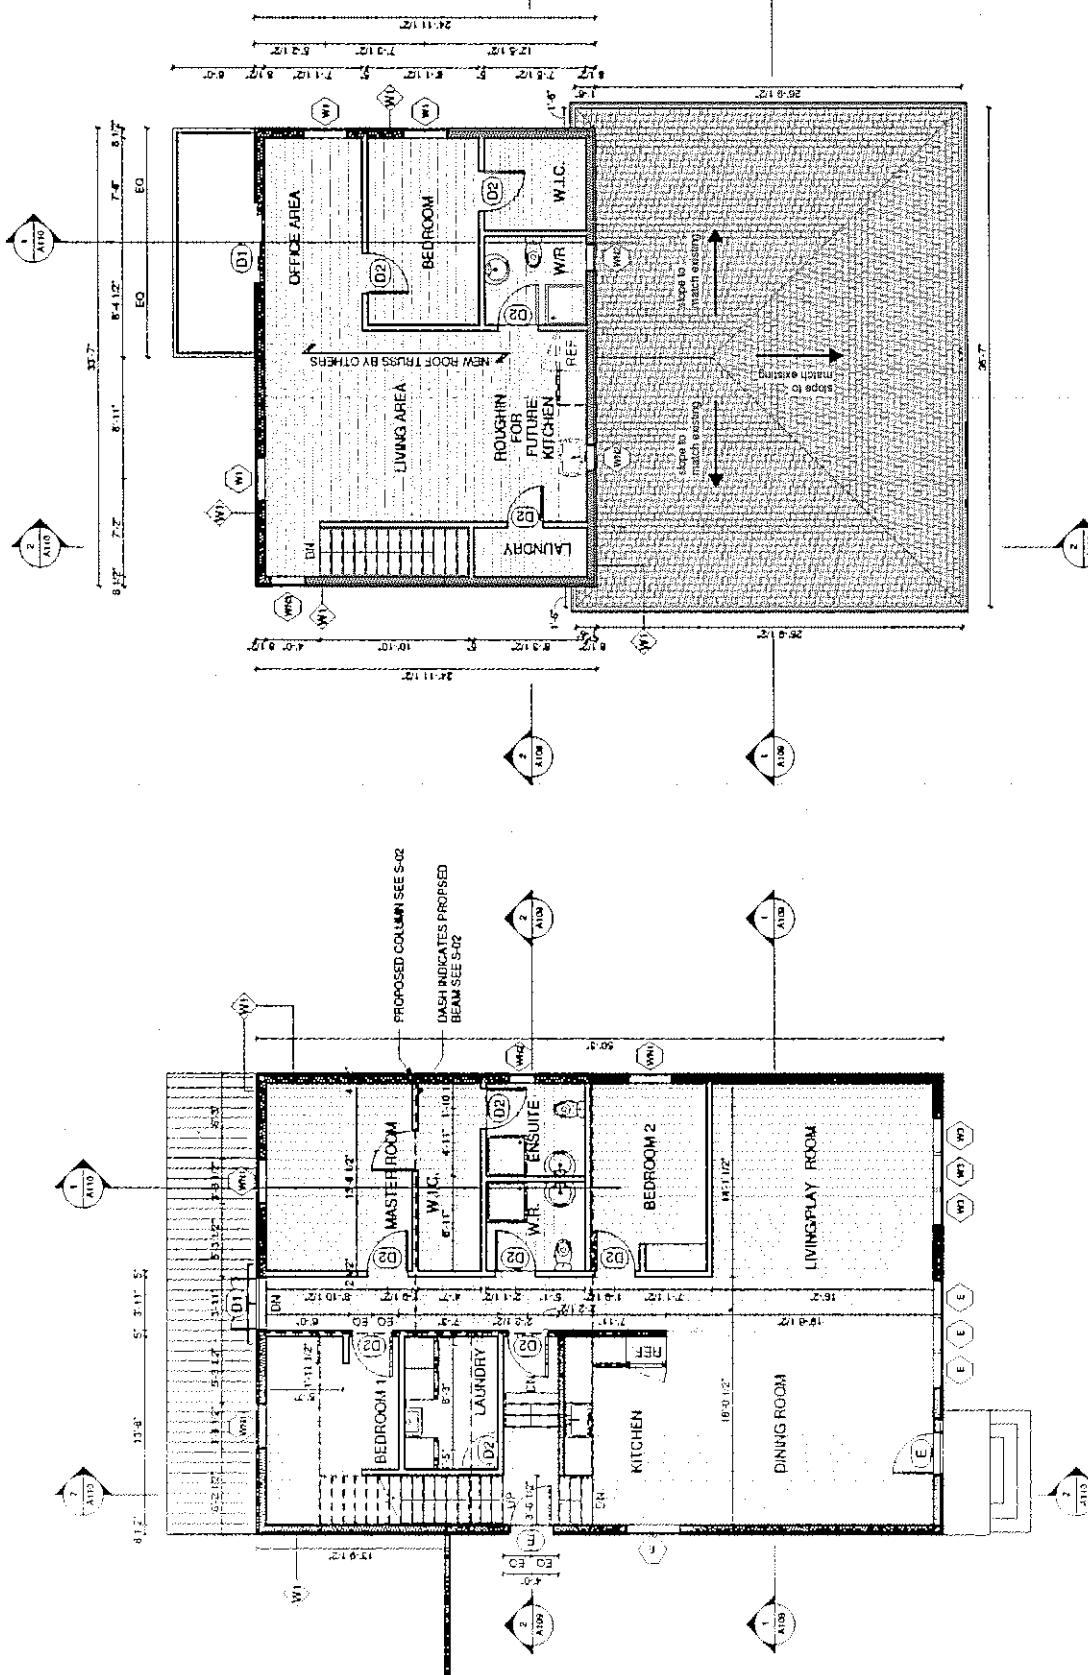



IBM Engineers Inc.
333 East 42nd St., New York 17, N.Y.



PLEKS

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ENCLOSURE

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7

This architectural drawing illustrates the addition of a new section to an existing building. The overall width of the addition is 35' 7", with a side wing extending 18' 3 1/2". The main addition has a total depth of 12' 0" and a side wing depth of 11' 11 1/2". The roof pitch is 4/12. The drawing shows the placement of new roof rafters (labeled 1 and 2) and the retention of existing rafters. A note specifies that new roof rafters should be added on site to support the new roof board, while existing rafters remain. The drawing includes a north arrow and several reference dates: 27-11-12, 28-3-12, and 27-11-12.

This architectural drawing illustrates a building footprint with various sections labeled:

- EXISTING GABLE TO REMAIN**: A section of the roofline on the left side.
- EXISTING ROOF TO BE DEMOLISHED**: A large rectangular area at the top center.
- EXISTING CHIMNEY TO BE DEMOLISHED**: A small rectangular chimney structure.
- EXISTING ROOF TO BE ADDED**: A hatched rectangular area representing the new roof extension.
- EXISTING HIP RAFTERS TO EXTEND AND SIDGE BOARD TO CONNECT W/ ADDITION**: Labels for the structural components of the new addition.

The drawing shows a complex roof system with multiple planes and a central chimney. The new addition is planned to extend the existing hip rafters and include a ridge board to connect with the original structure.

ROOF DEMOLITION PLAN

1

PROPOSED ROOF PLAN



IBM Engineers Inc.
10 Ashland Lane, Inc.
P.O. Box 1000, Somers, NY 10589-1000
www.ibe.com



PIEKS


14.000 M. E.

સ્વરૂપ
સાહિત્ય

PROPOSED SOUTH ELEVATION

171

A105

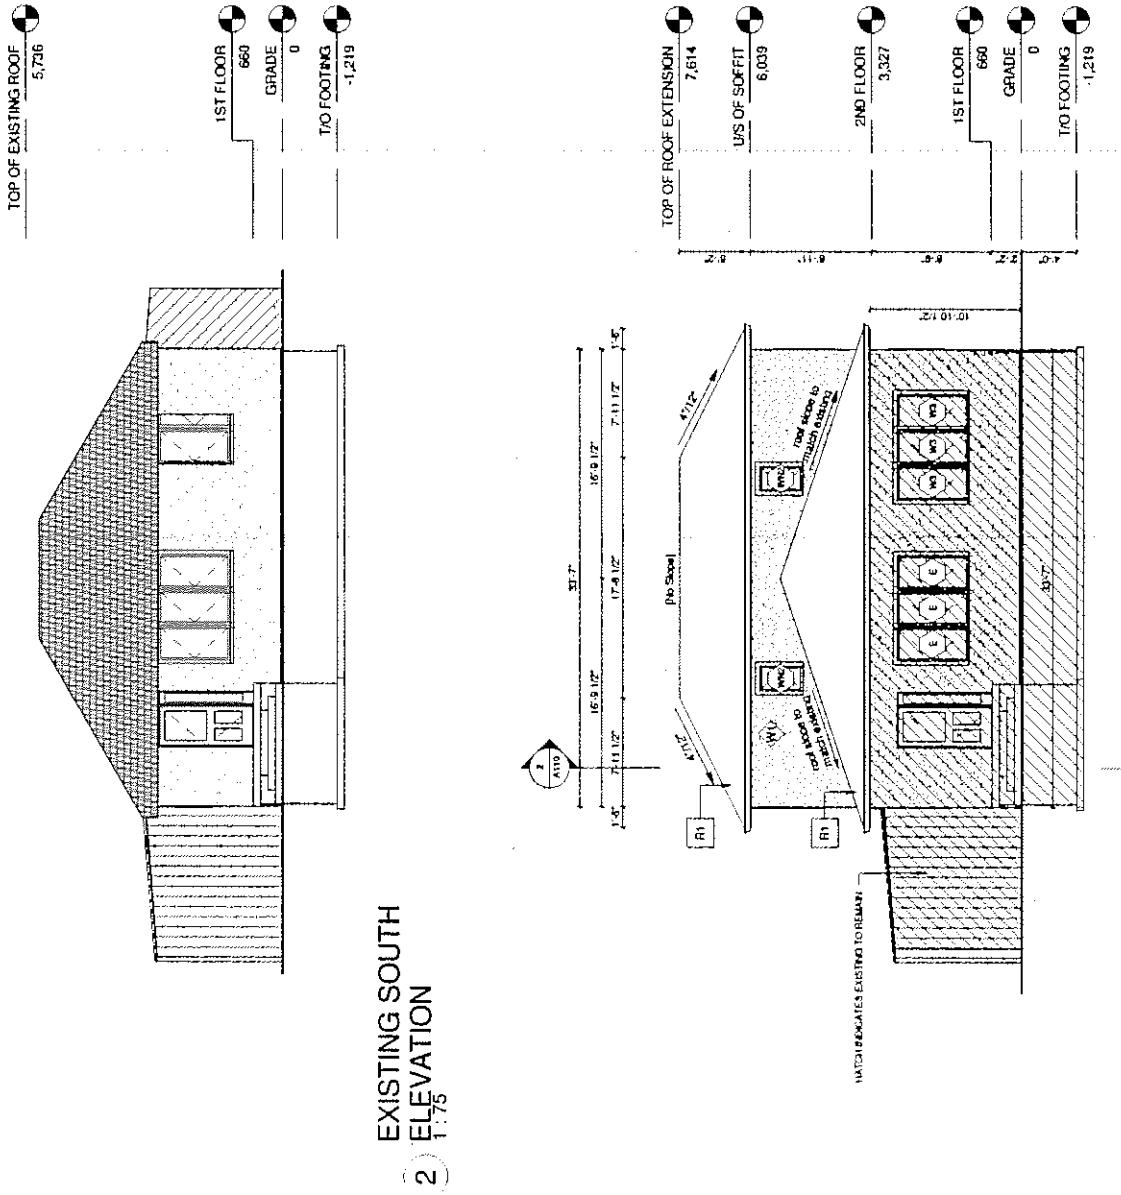




TERM Engineers Inc.
113 Adams Center Dr.
Waukesha, WI 53188-1972
www.terme.com




104 CLIFF CAMEON		EXISTING / PROPOSED WEST ELEVATION		Date	06/04/01
Existing	Proposed	Existing	Proposed	Date	Comments
SP	SP	SP	SP	06/04/01	
Dim 10' 0"	Dim 10' 0"	Dim 10' 0"	Dim 10' 0"	06/04/01	

A106

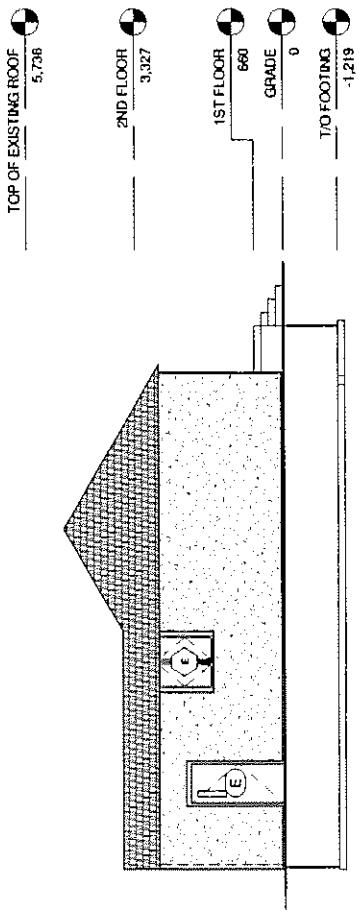

EXISTING WEST
ELEVATION
1:75
(2)

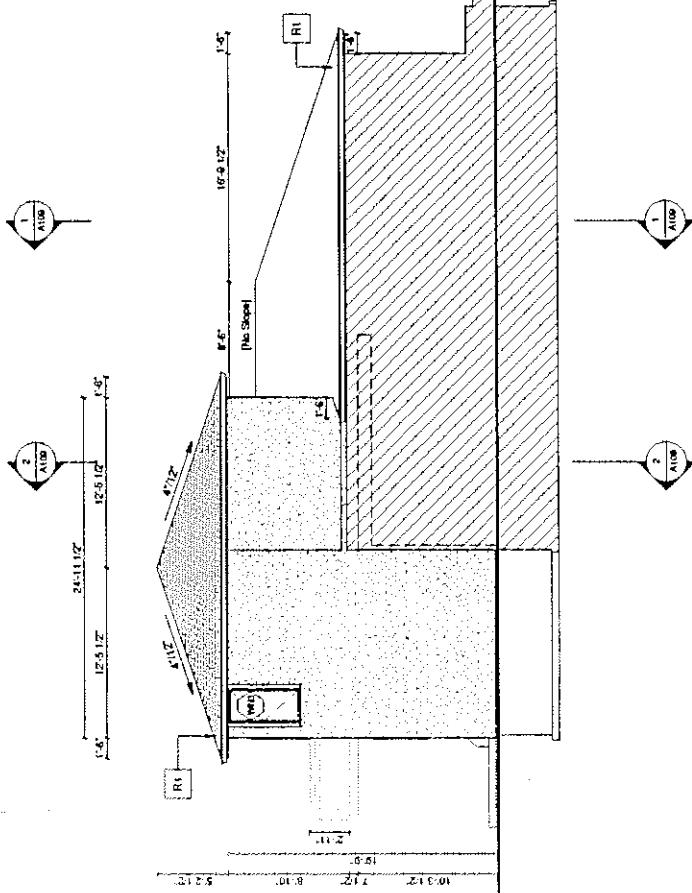

PROPOSED WEST
ELEVATION
1:75

**PROPOSED NORTH
ELEVATION**

1

Drawing No.

Date:

Page:

**PLEKS**

Architectural Services

Printed on:

JO GLEN CAMERON

Drawing No.:

EXISTING /
PROPOSED EARTH
ELEVATION

Date:

SP


Drawn by:

JG

Revised by:

Page:

1 75

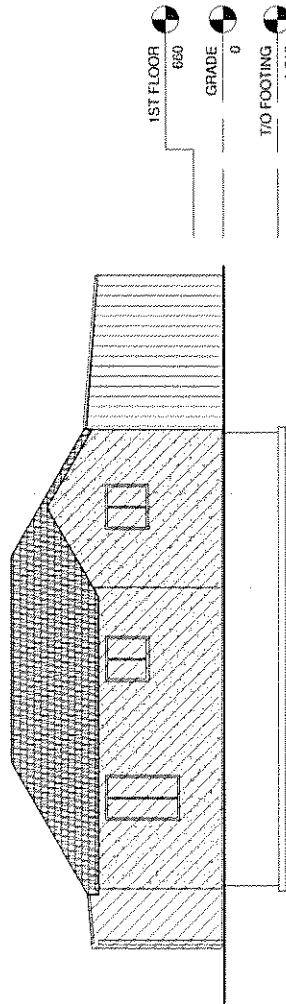**TBM**
Engineers Inc.1001188912
1001188912
2015-05-27
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TBMPRINTED ON
10/15/2015
BY: JG


**EXISTING NORTH
ELEVATION**

2


TOP OF EXISTING ROOF
5/736

(No Scale)

1:75

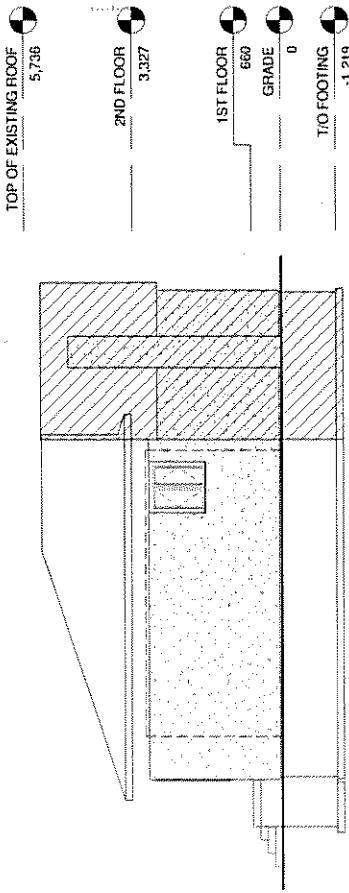

**EXISTING EAST
ELEVATION**
(2) **1:75**

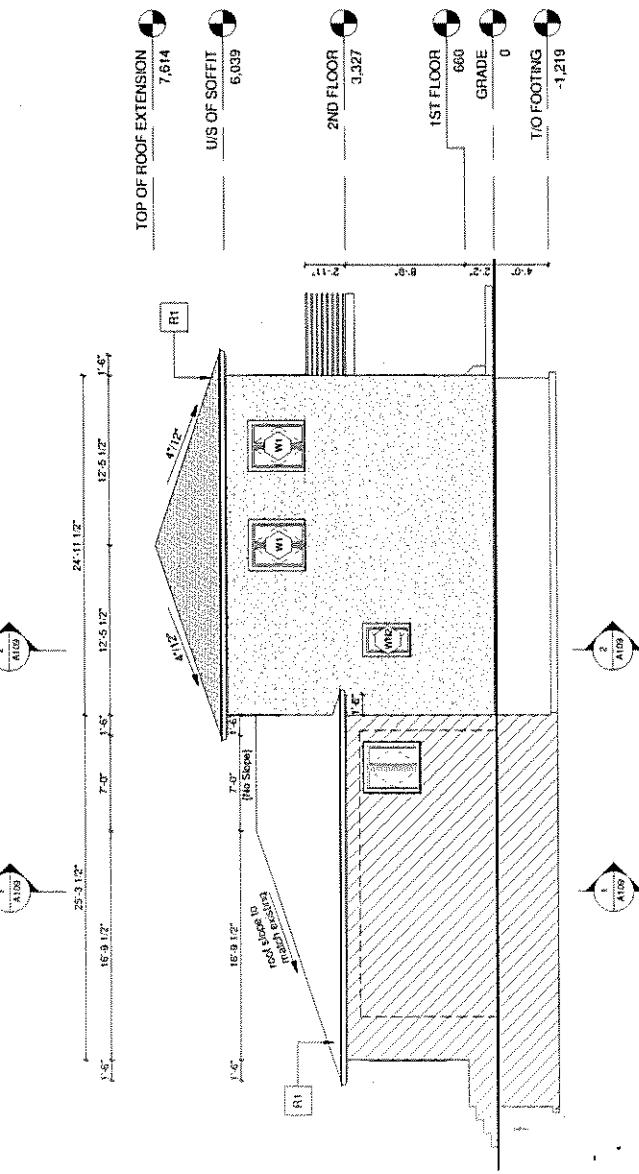

**PROPOSED EAST
ELEVATION**
(1) **1:75**

TOP OF EXISTING ROOF
5,736

2ND FLOOR
3,327
1ST FLOOR
660
GRADE
0
T/O FOOTING
-1,219

TOP OF ROOF EXTENSION
7,614
UIS OF SOFFIT
6,039
2ND FLOOR
3,327
1ST FLOOR
660
GRADE
0
T/O FOOTING
-1,219

24'-11 1/2"
12'-5 1/2"
1'-6"
1'-6"
1'-6"
1'-6"
1'-6"
1'-6"
1'-6"
1'-6"


(2)

(1)



THM Engineers Inc.

113 Adams Lane, Inc.
Waukesha, WI (414) 542-0773
www.thmwi.com
Engineering • Architecture • Land Surveying • General Contracting

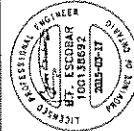


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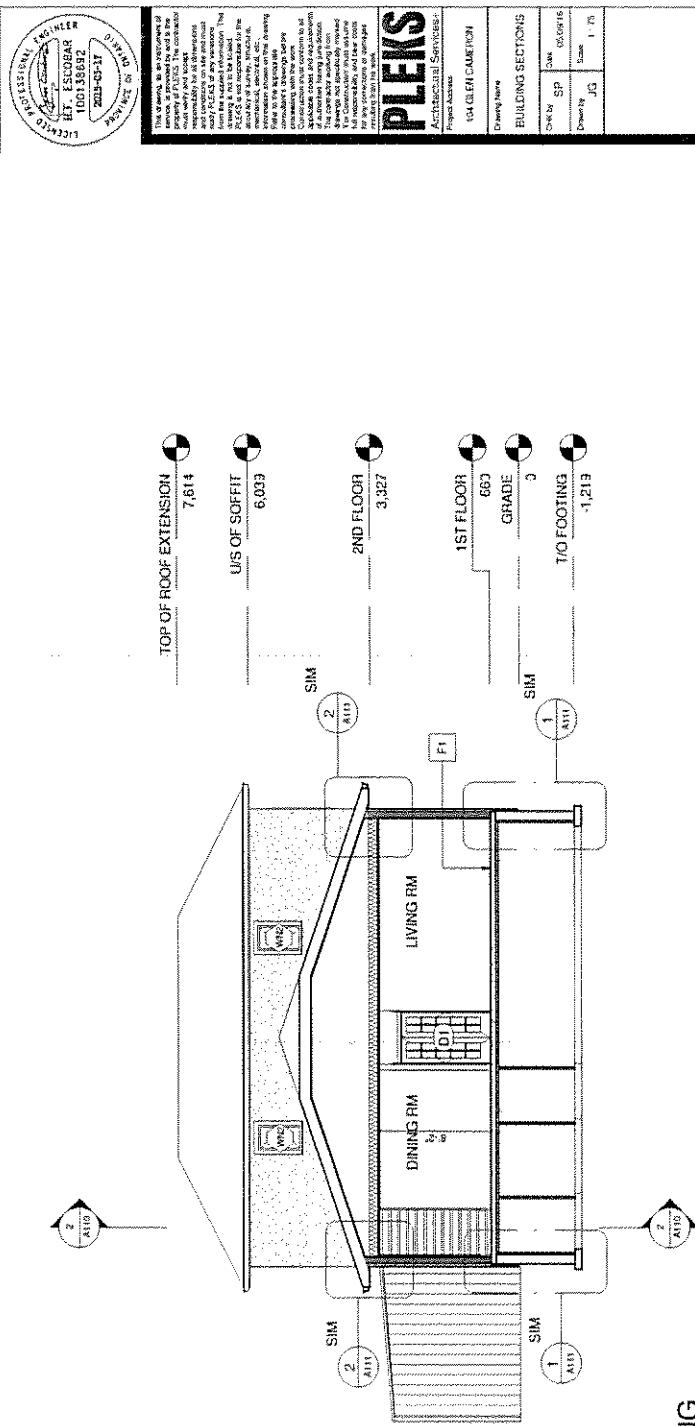
Architectural Services

Project No.: 92-0000	111 GLEN CAMERON
Owner:	Proposed East Elevation
Date:	SP
Scale:	1:75
Drawings:	1
Comments:	None

Drawing No:	A108
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SECTION A - E/W
PROPOSED
1:75



SECTION B - EXISTING
E/W
1:75

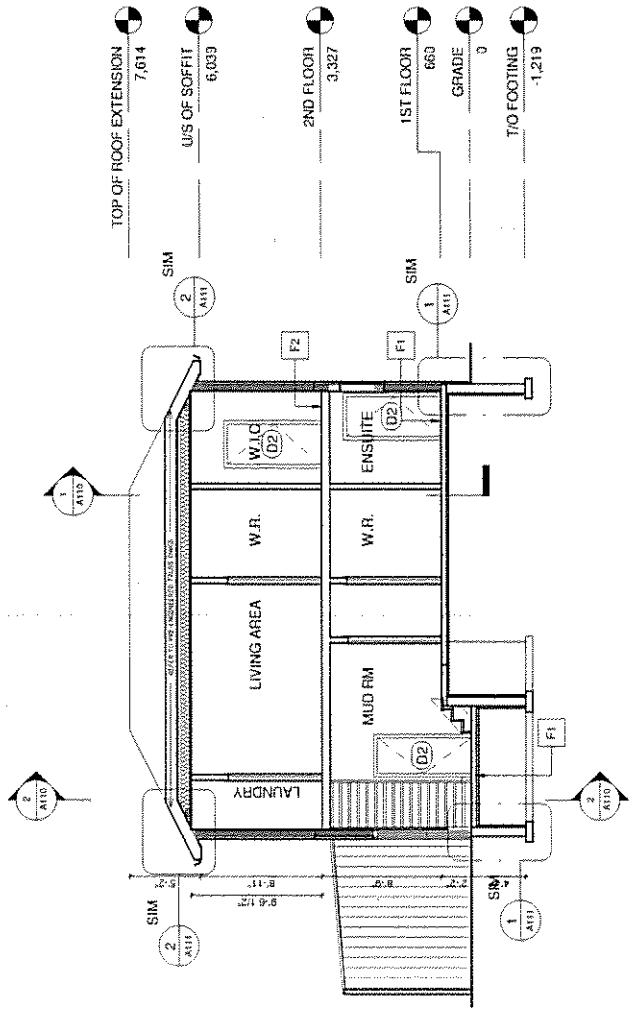

THM Engineers Inc.
132 Atlantic Lane
Wellesley Hills, MA 02481-4670
www.thmenginc.com
thmenginc@gmail.com



Architectural Services

Project Access

104 CLERICAMON

Drawing Name

BUILDING SECTIONS

Check By SP Date Drawn

104 09/06/13

Drawn By JG Scale 1:75


Drawing No.

(1)

A109




BMI Engineers Inc.
100 Avenue Louis Dr.
Montreal, Quebec H3C 2R2
www.bmi.ca

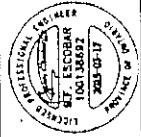


PIEKS

Architectural Services
and Areas

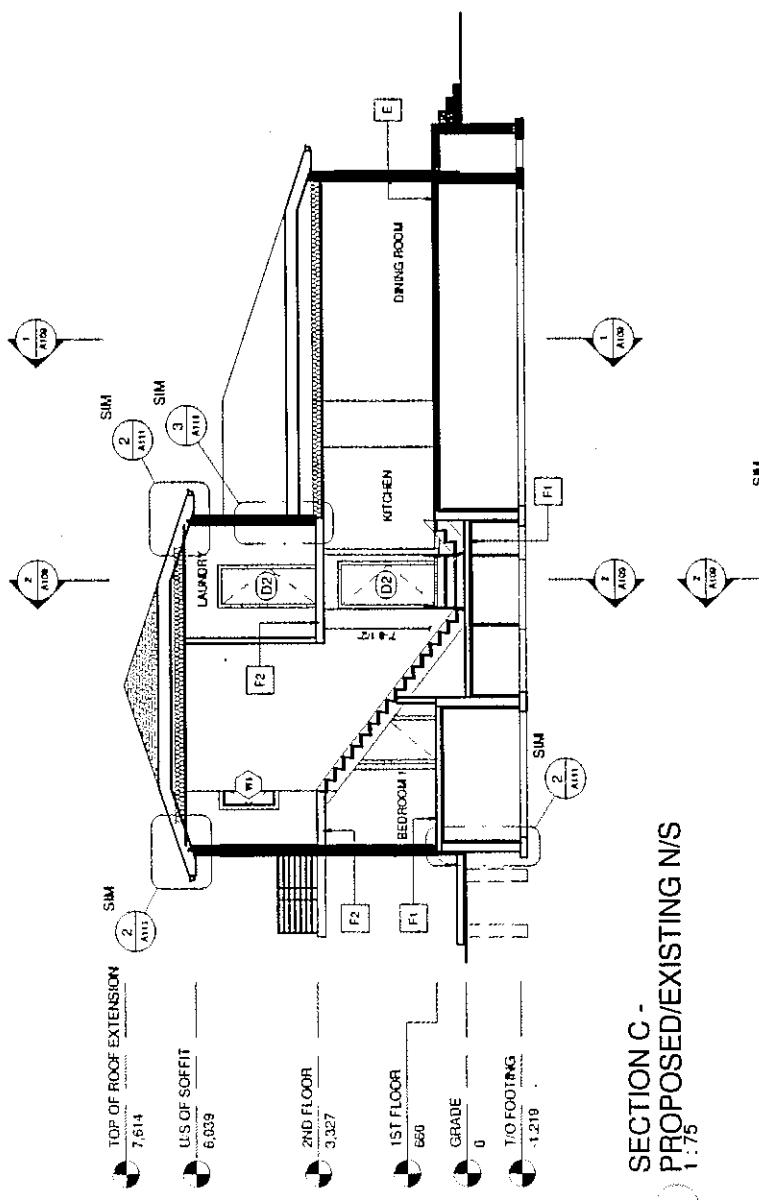

**SECTION C -
PROPOSED/EXISTING N/S
1:75**

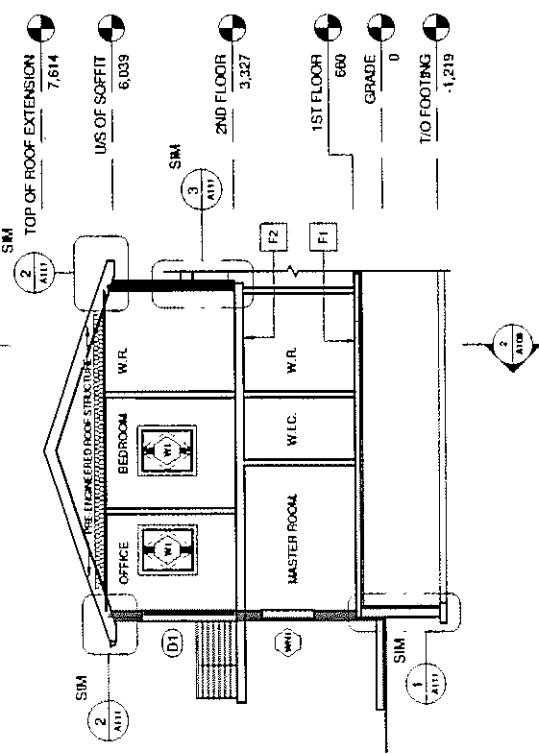

WALL SECTION A -
BALCONY
1:75

FOOTING DETAIL


1

1:10

INTERIOR CEILING PLATE
CANTILEVER SPAN 4.5m
CLEARANCE 2.5m
MIN. BLOCK TALL 0.45m

REMOVAL OF EXISTING
SIGHT HANGERS TO PROVIDE
ACOUSTIC SEALANT
AS REQUIRED & PROVIDE
INTERIOR WALL FINISH ON
EXISTING CONSTRUCTION

DETAILS
Dwg No. SP-26
Date 06/21/16
Drawing JG 1-10
Change No.

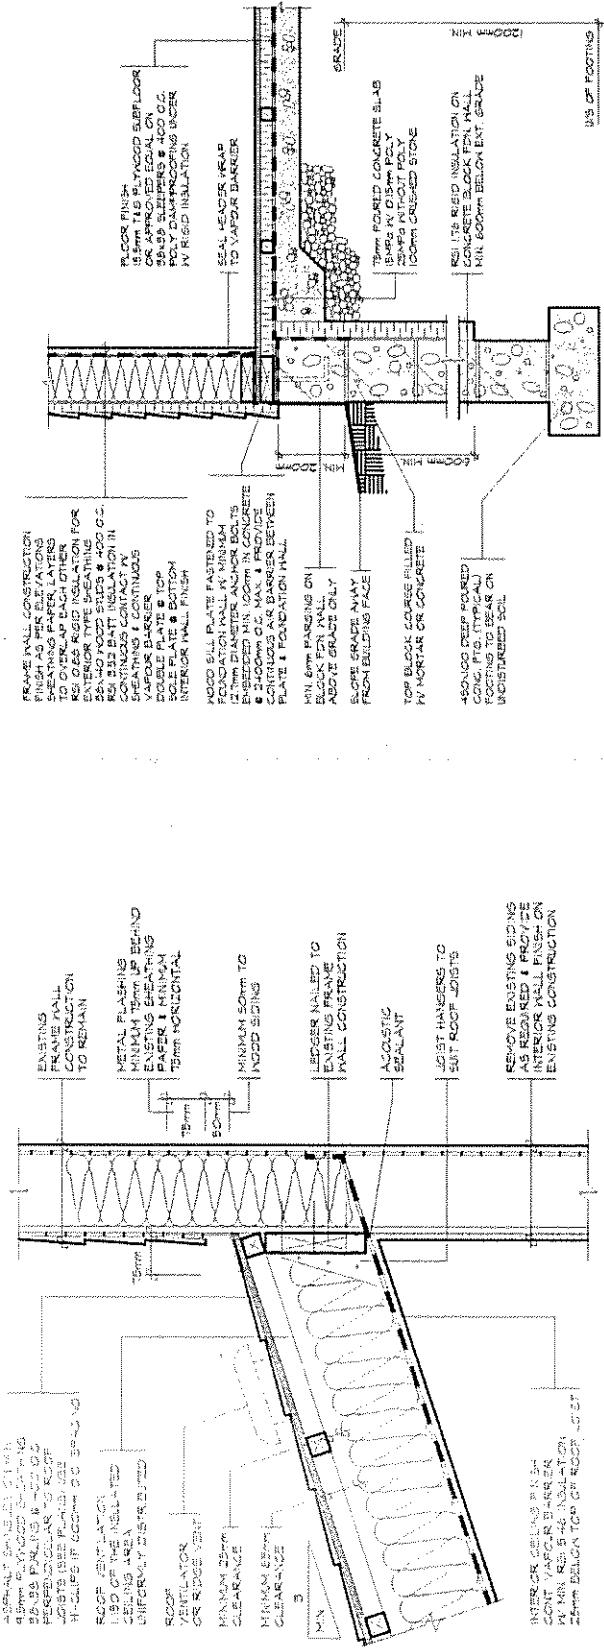

**ROOF CONNECTION
DETAIL**


3

1:10

SOFFIT DETAIL

2

1:10

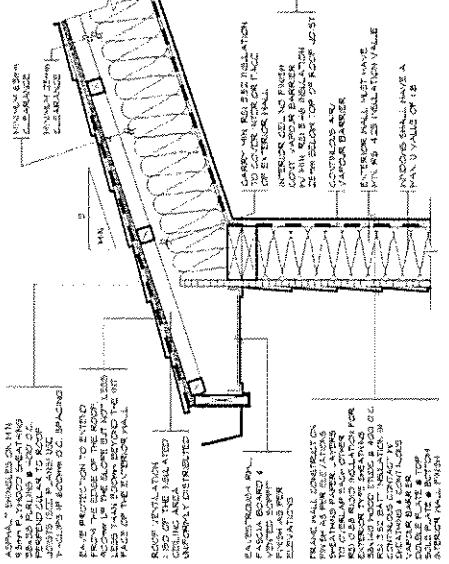

TM
TM Engineers Inc.
GENERAL CONTRACTOR
131 Atlantic Avenue
Wellesley, MA 02481-3070
www.tmengeersinc.com
tmengeersinc@gmail.com

TM
TM Engineers Inc.
GENERAL CONTRACTOR
131 Atlantic Avenue
Wellesley, MA 02481-3070
www.tmengeersinc.com
tmengeersinc@gmail.com

PLEXIS
Architectural Services
Project Advisor
DALE GLEN CAMERON
Drawing Name
DETAILS
Dwg No. SP-26
Date 06/21/16
Drawing JG 1-10
Change No.

Memorandum to the City of Markham Committee of Adjustment
September 7, 2017

File: A/112/17
Address: 104 Glen Cameron Road, Thornhill
Applicant: Ron Pansino
Owners: Kiril Penkov & Teodora Buhteva
Hearing Date: Wednesday September 13, 2017

The following comments are provided on behalf of the West Team:

The applicant is requesting relief from the following requirements of By-law 2237, as amended:

a) **Section 2.11:**

to permit a second kitchen on the second floor within a single residential dwelling unit; whereas, the By-law definition of 'Dwelling, Single Family' permits one kitchen within a single residential dwelling unit;

b) **Infill By-law 101-90, Section 1.2 (i):**

a maximum building height of 9.22 m whereas the By-law permits a maximum building height of 8.6 m;

c) **Amending By-law 61-94, Section 4:**

a minimum east side yard setback of 1.49 m whereas the By-law requires a minimum side yard setback of 1.8 m; as it relates to an addition to the existing dwelling.

BACKGROUND

Property Description

The 650 m² property is located on the north side of Glen Cameron Road, approximately 45 m east of Lillian Avenue. The property contains a one storey detached dwelling constructed circa 1953 and mature vegetation. To the north, east and west of the property are single detached dwellings, and to the south across Glen Cameron Road is a two storey industrial building containing a courier company and a tire retailer.

Proposal

The applicant is proposing a second storey addition to the existing dwelling while providing the same side yard setbacks as the first floor.

Official Plan & Zoning

Official Plan

The site is designated 'Residential Low Rise' in the 2014 Official Plan (partially approved as of October 29, 2015, May 26, 2016, March 10, 2017 & April 21, 2017) which provides for low rise housing forms including single detached dwellings.

Zoning By-law

The property is zoned R4S (Residential Fourth Density Special) under By-law 2237, as amended which permits single detached dwellings. This zone category only permits one kitchen within a single residential dwelling unit.

Residential Infill Zoning By-law

The property is also subject to Residential Infill Zoning By-law 101-90, which amends By-law 2237. The intent of this by-law amendment is to ensure that any redevelopment of existing residential dwellings reflects the prevailing established and stable character of the neighbourhood. In order to maintain the character of the existing neighbourhood, the infill by-law specifies zoning standards for building depth, garage projection, garage width, floor area ratio, height, front yard setback and number of stories.

Applicant's Stated Reason(s) for Not Complying with Zoning

According to the information provided by the applicant on the application form, the "Building exists. Constructed 1953".

COMMENTS

The Planning Act states that four tests must be met in order for a variance to be granted by the Committee of Adjustment:

- a) The variance must be minor in nature;
- b) The variance must be desirable, in the opinion of the Committee of Adjustment, for the appropriate development or use of land, building or structure;
- c) The general intent and purpose of the Zoning By-law must be maintained;
- d) The general intent and purpose of the Official Plan must be maintained.

Second Kitchen Variance

The applicant is proposing a second kitchen, whereas, a maximum of one kitchen is permitted. Staff have no objections in principle to the requested variance. However, based on the plans submitted with the application, the second kitchen will be located within the proposed second floor addition which also contains a bedroom and washroom and this area appears to be consistent with the definition of a "Secondary Suite" described in the City's 2014 Official Plan. A Secondary Suite is defined as "a second residential unit in a detached house, semi-detached house or rowhouse that consists of one or more rooms designed, occupied or intended for use, including occupancy, by one or more persons as an independent and separate residence in which a facility for cooking, sleeping facilities and sanitary facilities are provided for the exclusive use of such person or persons."

The owner may be required to submit an additional variance application if the proposed renovations are deemed to be a "Secondary Suite" through the Building Permit process.

Increased Building Height Variance

The applicant is proposing a maximum building height of 9.22 m, whereas, a maximum building height of 8.6 m is permitted. This represents an increase 0.62 m or approximately 7 percent. Building Height is measured from the centre line of the road to the peak of the roof ridge. Staff does not anticipate any adverse impacts to adjacent property owners as a result of the requested variance.

Reduced Side Yard Setback

The applicant is proposing a reduced a minimum east side yard setback of 1.49 m, whereas, a minimum side yard setback of 1.8 m is required. The applicant is proposing to align the proposed second floor exterior wall with the existing first floor exterior wall. Staff does not anticipate any adverse impacts to adjacent property owners as a result of the requested variance.

Tree Preservation

Should the Committee decide to approve this application, Staff recommends that the owner be required, as a condition of approval, to submit a tree assessment and preservation plan in accordance with the City of Markham, Trees for Tomorrow Streetscape Manual, as amended, to the satisfaction of the Director of Planning and Urban Design Department prior to site work. In addition, subject to review of the tree assessment and preservation plan, tree replacement fees are to be paid to the City of Markham, if required by the Director of Planning and Urban Design or his designate.

PUBLIC INPUT SUMMARY

No written submissions were received as of September 7, 2017. It is noted that additional comments may be received after the writing of this report, and the Secretary-Treasurer will provide comment on this at the Committee of Adjustment Hearing.

Zoning Preliminary Review Not Undertaken

The owner has confirmed that a Zoning Preliminary Review (ZPR) has not been undertaken. Consequently, it is the owner's responsibility to ensure that the application has accurately identified all the variances to the Zoning By-law required for the proposed development. If the variances in the application contains errors, or if the need for additional variances are identified during the Building Permit review process, further variance application(s) may be required to address the outstanding matters and there will be a delay in application processing.


CONCLUSION

It is the opinion of the Planning staff that the requested variances meet the four tests of the Planning Act. However, it is recommended that the application is deferred to provide applicant an opportunity to confirm with the Zoning Department whether an additional variance is required to permit a "Second Dwelling Unit" as well as to re-circulate and re-notify the application, if required.

Notwithstanding the above, the onus is ultimately on the applicant to demonstrate why they should be granted relief from the requirements of the zoning by-law, and how they satisfy the tests of the Planning Act required for the granting of minor variances.

Should the Committee see merit in approving the application as requested, it is recommended that the conditions provided in Appendix "A" be attached to any approval of this application.

PREPARED BY:

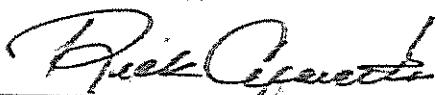

Rick Cefaratti, MCIP, RPP, Planner II, West District

REVIEWED BY:



David Miller, MCIP, RPP, Manager, West District

File Path: Amanda\File\17 171072\Documents\District Team Comments Memo

APPENDIX "A"
CONDITIONS TO BE ATTACHED TO ANY APPROVAL OF FILE A/112/17

1. The variances apply only to the proposed development as long as it remains;
2. That the variances apply only to the subject development, in substantial conformity with the plan(s) attached as 'Appendix A' to this Staff Report, and that the Secretary-Treasurer receive written confirmation from the Director of Planning and Urban Design or designate that this condition has been fulfilled to his or her satisfaction.
3. Submission of a Tree Assessment and Preservation Plan, prepared by a qualified arborist in accordance with the City's Streetscape Manual (2009), as amended, to be reviewed and approved by the City, and that the Secretary-Treasurer receive written confirmation from the Director of Planning and Urban Design or designate that this condition has been fulfilled to his/her satisfaction, and that any detailed Siting, Lot Grading and Servicing Plan required as a condition of approval reflects the Tree Assessment and Preservation Plan;
4. That prior to the commencement of construction or demolition, tree protection be erected and maintained around all trees on site in accordance with the City's Streetscape Manual, including street trees, in accordance with the City's Streetscape Manual (2009) as amended, and inspected by City Staff to the satisfaction of the Director of Planning and Urban Design or their designate;
5. That tree replacements be provided and/or tree replacement fees be paid to the City if required in accordance with the Tree Assessment and Preservation Plan, and that the Secretary-Treasurer receive written confirmation that this condition has been fulfilled to the satisfaction of the Director of Planning and Urban Design or designate.

CONDITIONS PREPARED BY:



Rick Cefaratti, MCIP, RPP, Planner II, West District

104 GLEN CAMERON RD
ADDITION / ALTERATION

Appendix A



THAI Engineers Inc.
Engineering Services
Structural, Civil, Geotechnical,
Water, Environmental, Construction
and General Consulting




PLEKS

Drawn by:	SP:	Date:
Checked by:	JG:	
Approved by:		



Item	Change Building Code Data Matrix		Office Reference
	<input type="checkbox"/> New	<input checked="" type="checkbox"/> Change of Use	
1 Project Description	<input type="checkbox"/>	<input checked="" type="checkbox"/>	<input type="checkbox"/> Part 3 <input checked="" type="checkbox"/> Part 9 <input type="checkbox"/> Part 11
2 Land Ownership (if C)	<input type="checkbox"/>	<input type="checkbox"/>	31.2(1)(i) 9.102.
3 Building Area (in m ²) Existing 91.8 New 53.8 Total 152.6 1.4.1(2)(i)	<input type="checkbox"/>	<input type="checkbox"/>	1.4.1(2)(i)
4 Gross Area (in m ²) Existing 91.8 New 31.6 Total 23.4 1.4.1(2)(i)	<input type="checkbox"/>	<input type="checkbox"/>	1.4.1(2)(i)
5 Number of Stories Active Grade 2 Below Grade 0	<input type="checkbox"/>	<input type="checkbox"/>	1.4.1(2)(i)
6 Number of Stairs/Access Roads 1	<input type="checkbox"/>	<input type="checkbox"/>	32.2(1)(i) 32.5 9.102.
7 Building Classification RESIDENTIAL	<input type="checkbox"/>	<input type="checkbox"/>	32.2(3) 9.102.
8 Fire Alarms System Present	<input type="checkbox"/> Existing Building	<input type="checkbox"/> Standalone	3.2.2(3) 9.102.2
9	<input type="checkbox"/> In Electrical Room	<input type="checkbox"/> Not Required	
10 Sprinklers required	<input type="checkbox"/> Yes <input checked="" type="checkbox"/> No	<input type="checkbox"/> Yes <input checked="" type="checkbox"/> No	10A
11 Fire Alarm Required	<input type="checkbox"/> Yes <input checked="" type="checkbox"/> No	<input type="checkbox"/> Yes <input checked="" type="checkbox"/> No	9.10.18.
12 Water Service Supply is Adequate	<input type="checkbox"/> Yes <input checked="" type="checkbox"/> No	<input type="checkbox"/> Yes <input checked="" type="checkbox"/> No	10A
13 High Bay	<input type="checkbox"/> Yes <input checked="" type="checkbox"/> No	<input type="checkbox"/> Yes <input checked="" type="checkbox"/> No	10A
14 Permitted Construction <input checked="" type="checkbox"/> Permanent <input type="checkbox"/> Non-permanent	<input type="checkbox"/> Permanent <input checked="" type="checkbox"/> Non-permanent	<input type="checkbox"/> Permanent <input checked="" type="checkbox"/> Non-permanent	9.10.6
15 Actual Construction	<input type="checkbox"/> Permanent <input checked="" type="checkbox"/> Non-permanent	<input type="checkbox"/> Permanent <input checked="" type="checkbox"/> Non-permanent	
16 Landscaping (Area in m ²) n/a	<input type="checkbox"/>	<input type="checkbox"/>	3.2.1(1)(b) 9.10.4
17 Occupied and Based in <input type="checkbox"/> Joint Venture <input type="checkbox"/> Partnership <input type="checkbox"/> Occupancy: _____	<input type="checkbox"/> Design of Building <input type="checkbox"/> Load <input checked="" type="checkbox"/> Persons <input type="checkbox"/> Load <input checked="" type="checkbox"/> Persons	<input type="checkbox"/> Yes <input checked="" type="checkbox"/> No <input type="checkbox"/> No (Exempt)	3.1.17 9.10.13
18 Fire Resistant Design	<input type="checkbox"/> Yes <input checked="" type="checkbox"/> No	<input type="checkbox"/> Yes <input checked="" type="checkbox"/> No	3.2 9.5.2
19 Material Substances	<input type="checkbox"/> Horizontal Assemblies <input type="checkbox"/> Vertical Assemblies <input type="checkbox"/> Used Derivatives of Ozone Depleting (ODC) Fire Retardant	<input type="checkbox"/> Horizontal Assemblies <input type="checkbox"/> Vertical Assemblies <input type="checkbox"/> Used Derivatives of Ozone Depleting (ODC) Fire Retardant	3.3.1(2) 3.3.1(2) 9.10.13(4) ~
20 Fire Resistance Rating (FRR) Hours	Hours 0	Hours 0	3.2.2(3) 3.2.1(4) 9.10.8 ~
21 Floor	Hours 0	Hours 0	
22 Wall	Hours 0	Hours 0	
23 Fire or Supporting Members	<input type="checkbox"/> Non-combustible Construction	<input type="checkbox"/> Non-combustible Construction	3.2.2(3) 3.2.1(4) 9.10.8 ~
24 Floor	Hours 0	Hours 0	
25 Latticework	Hours 0	Hours 0	
			3.2.2(3) 9.10.8 ~

SHEET LIST		SHEET NAME
A100	COVER PAGE	
A101	CONSTRUCTION NOTES	
A102	EXISTING DEMO & PROPOSED FOUNDATION PLAN	
A103	PROPOSED FIRST & SECOND FLOOR PLANS	
A104	ROOF PLAN DEMOLISHED & PROPOSED	
A105	EXISTING, PROPOSED SOUTH ELEVATION	
A106	EXISTING, PROPOSED WEST ELEVATION	
A107	EXISTING, PROPOSED NORTH ELEVATION	
A108	EXISTING, PROPOSED EAST ELEVATION	
A109	BUILDING SECTIONS CONTINUED	
A110	DETAILS	
S-01	FOUNDATION PLAN	
S-02	GROUND FLOOR PLAN	
S-03	SECOND FLOOR PLAN	

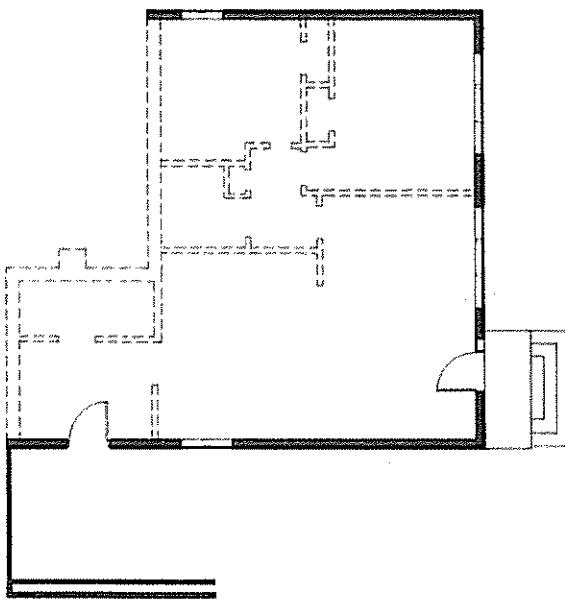

1ST FLOOR - DEMO

5
2

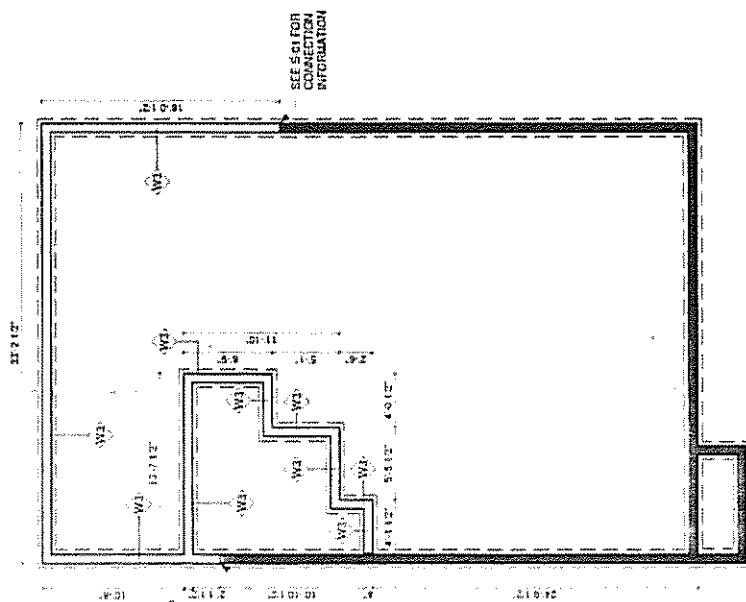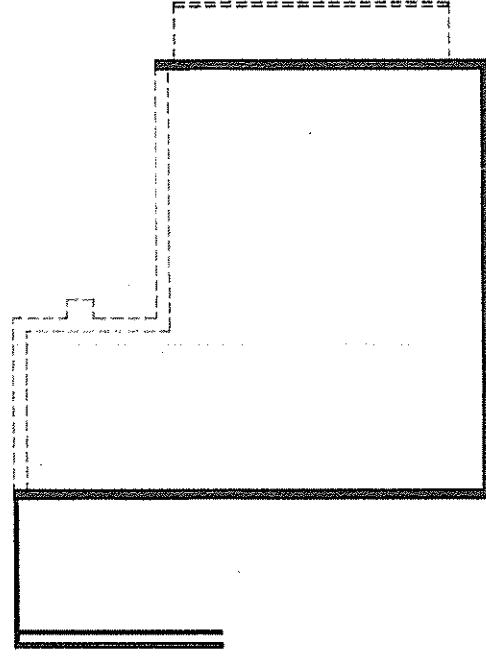

FOUNDATION PROPOSED


FOUNDATION - DEMO

FOU 1



A102

GENERAL NOTE:
PROPOSED WITNESSES FOR EXTERIOR OPERANDS, REFER TO FIG 1 & 2.

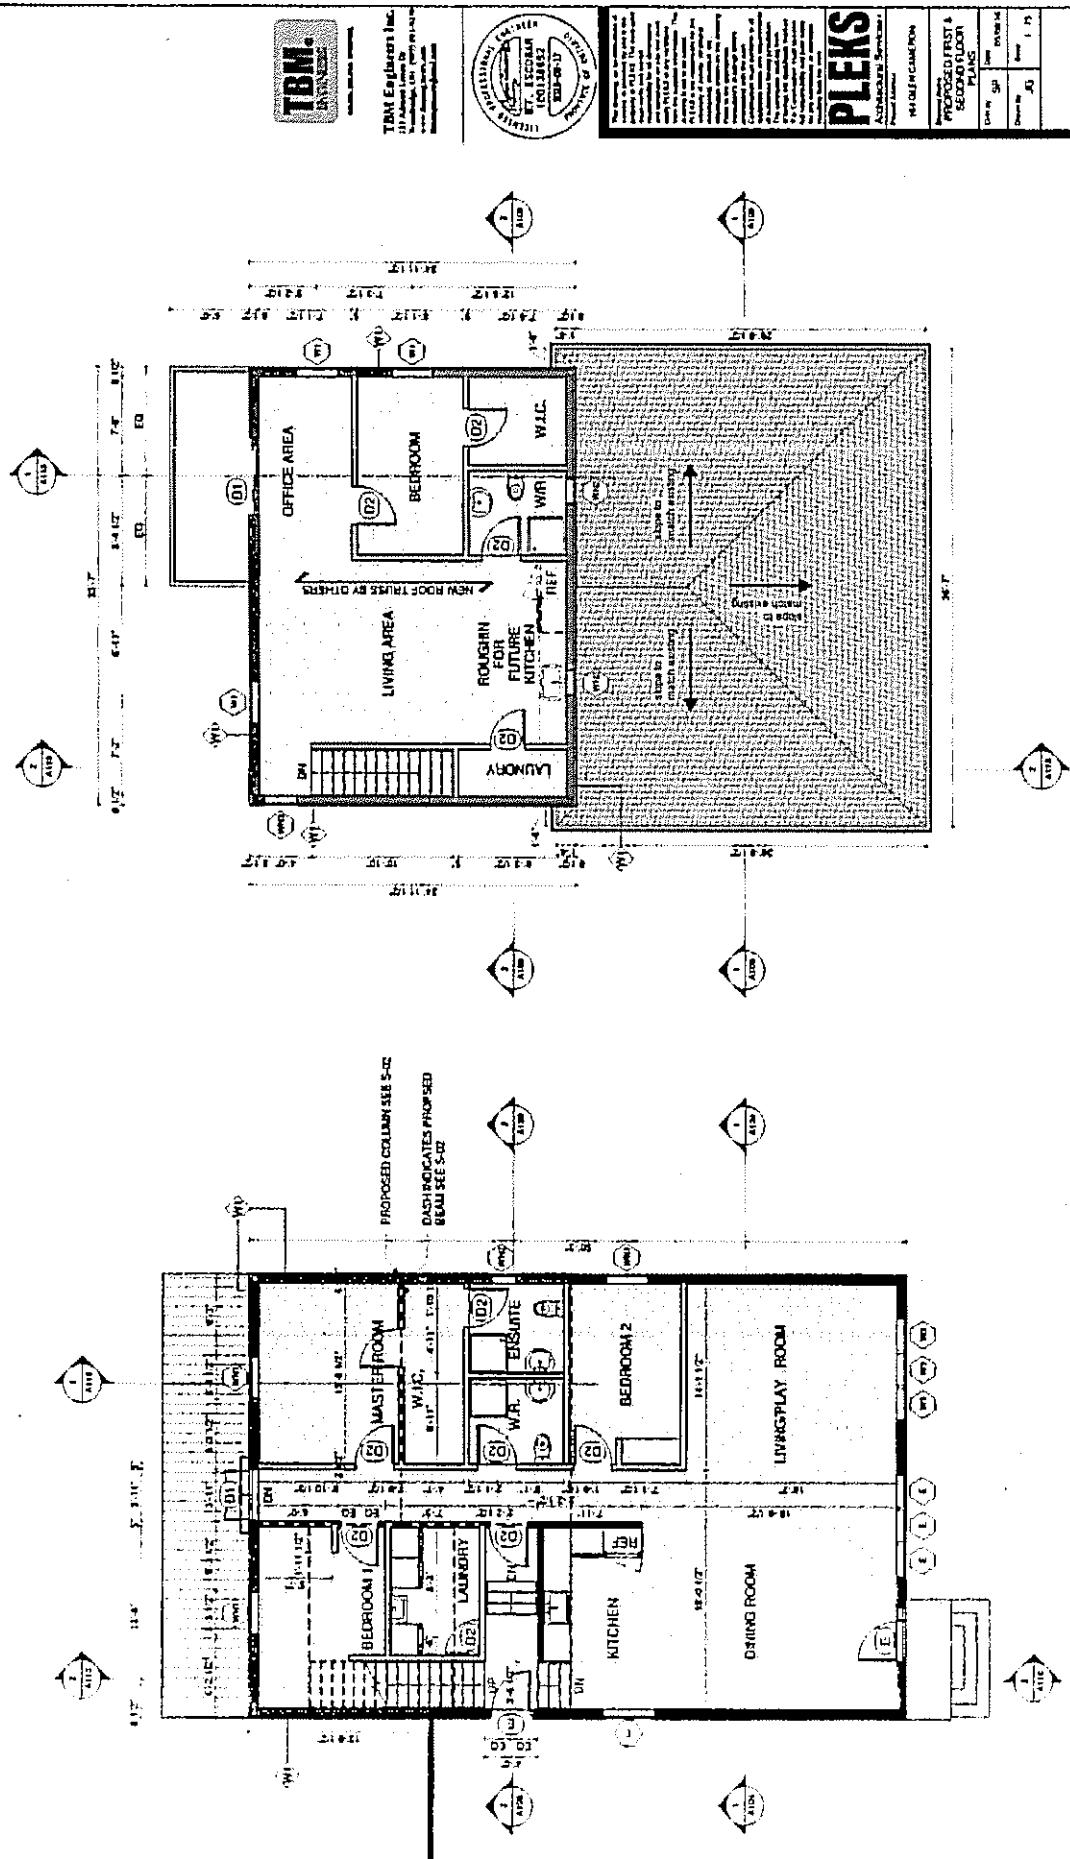

2 PROPOSED - 1ST FLOOR
1 1:75

1 PROPOSED - 2ND FLOOR
1 1:75

A103



TBM
Engineering
Architectural
Services



PLEXIS
Architectural Services

PROPOSED FIRST & SECOND FLOOR PLANS	
Length	50'
Breadth	40'
Area	2000 SF



A104

PLEKS

Architectural Services

The Gurnsey Company

ROOF PLAN

DEMOLISHED &

PROPOSED

E.P.

ROOF

DEMOLITION

S.C.

DEMOLITION

S.C.

DEMOLITION

S.C.

DEMOLITION

S.C.

DEMOLITION

PROPOSED ROOF PLAN

2 1:75

ROOF DEMOLITION PLAN

1 1:75



EXISTING RAFTERS TO BE REMOVED

EXISTING ROOF TO BE DEMOLISHED

EXISTING CHIMNEY TO BE DEMOLISHED

EXISTING ROOF TO BE DEMOLISHED

EXISTING GABLE TO BE REMOVED

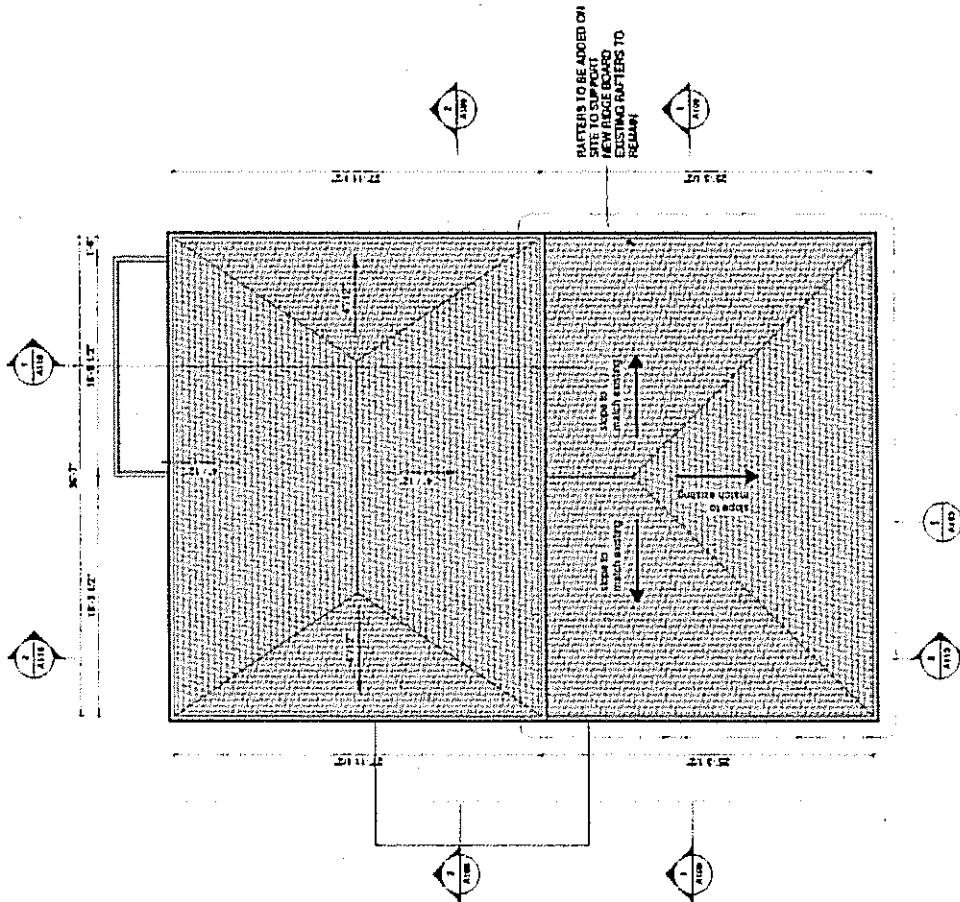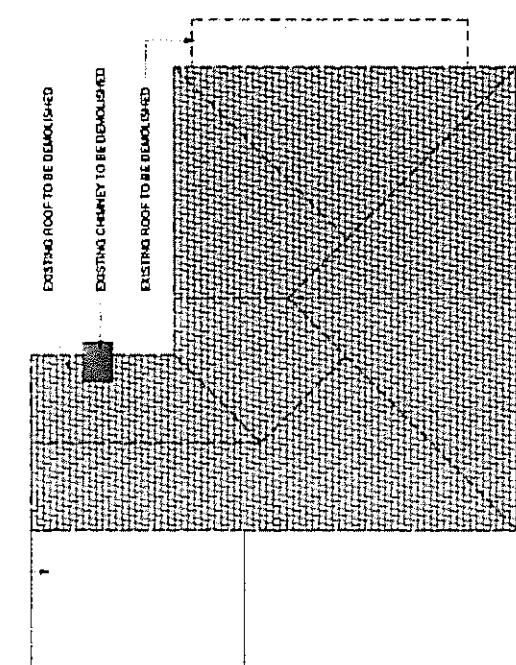
RAFTERS TO BE ADDED ON
SITE TO SUPPORT
NEW RIDGE BOARD
EXISTING RAFTERS TO
REMAINRAFTERS
TO BE ADDED
ON SITE
TO SUPPORT
NEW RIDGE
BOARD
EXISTING
RAFTERS
TO
REMAINTBW
Architects
Engineers
Planners
Landscapers
Interior Designers
Manufacturers
Suppliers
Consultants
Contractors
Manufacturers
Suppliers
Consultants
Contractors

A105


PLEKS



TBM Engineers Inc.
Architects & Engineers
1001 Lakeside Drive
Milwaukee, WI 53202
(414) 765-1000

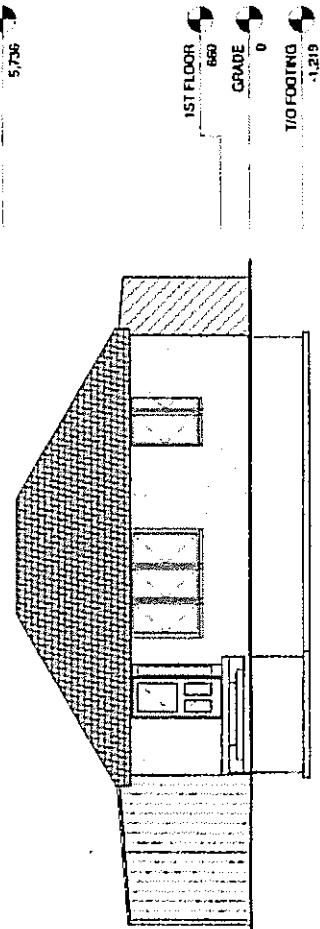

EXISTING SOUTH
ELEVATION
1:75

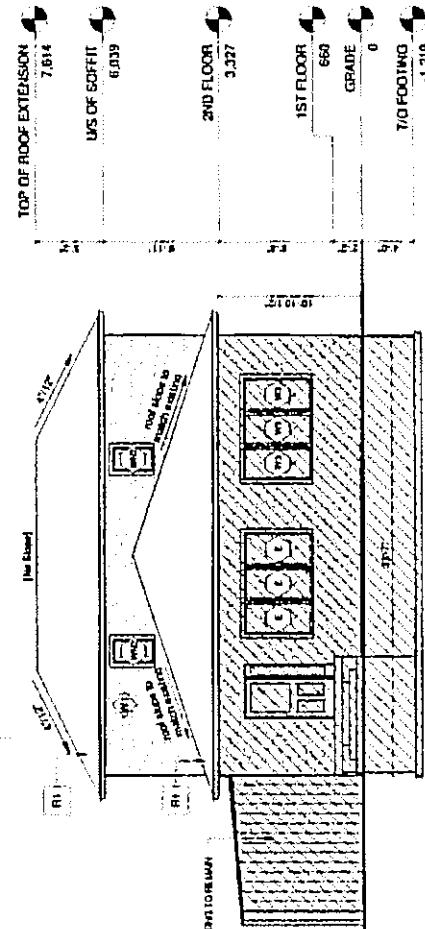

PROPOSED SOUTH
ELEVATION
1:75

1



1



1



A106



PIEK'S

Architectural Services
Engineering Services
Land Surveying Services
Construction Services
Vertical Measurement
Horizontal Measurement
Elevation
Level = SF
Floor
Elevation
Elevation
1 ft
1 m
10 ft
30 m


TBM Engineering
1981 Elevation
Architectural Services
Engineering Services
Land Surveying Services
Construction Services
Vertical Measurement
Horizontal Measurement
Elevation
Level = SF
Floor
Elevation
Elevation
1 ft
1 m
10 ft
30 m



EXISTING WEST
ELEVATION
2 1:75

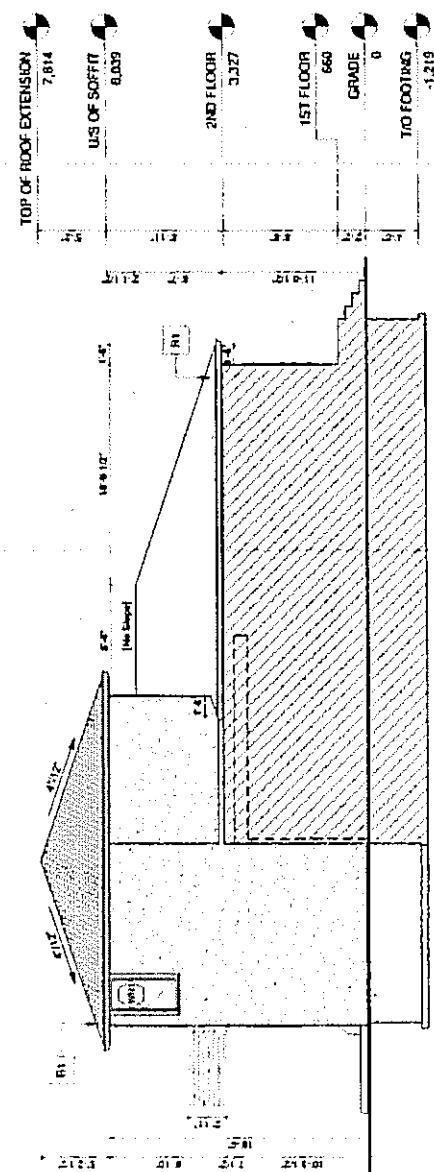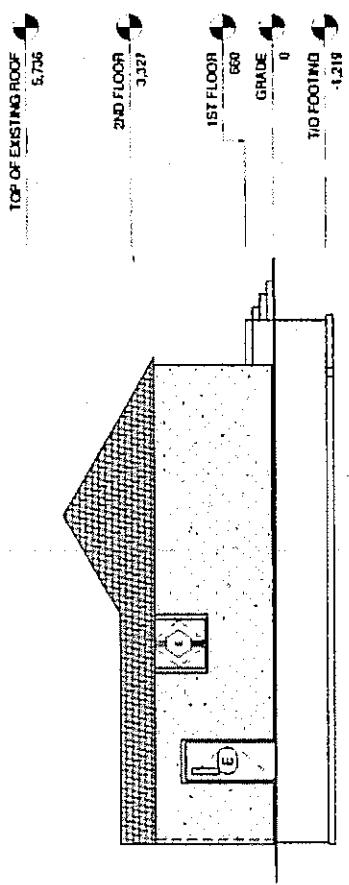

PROPOSED WEST
ELEVATION
1:75

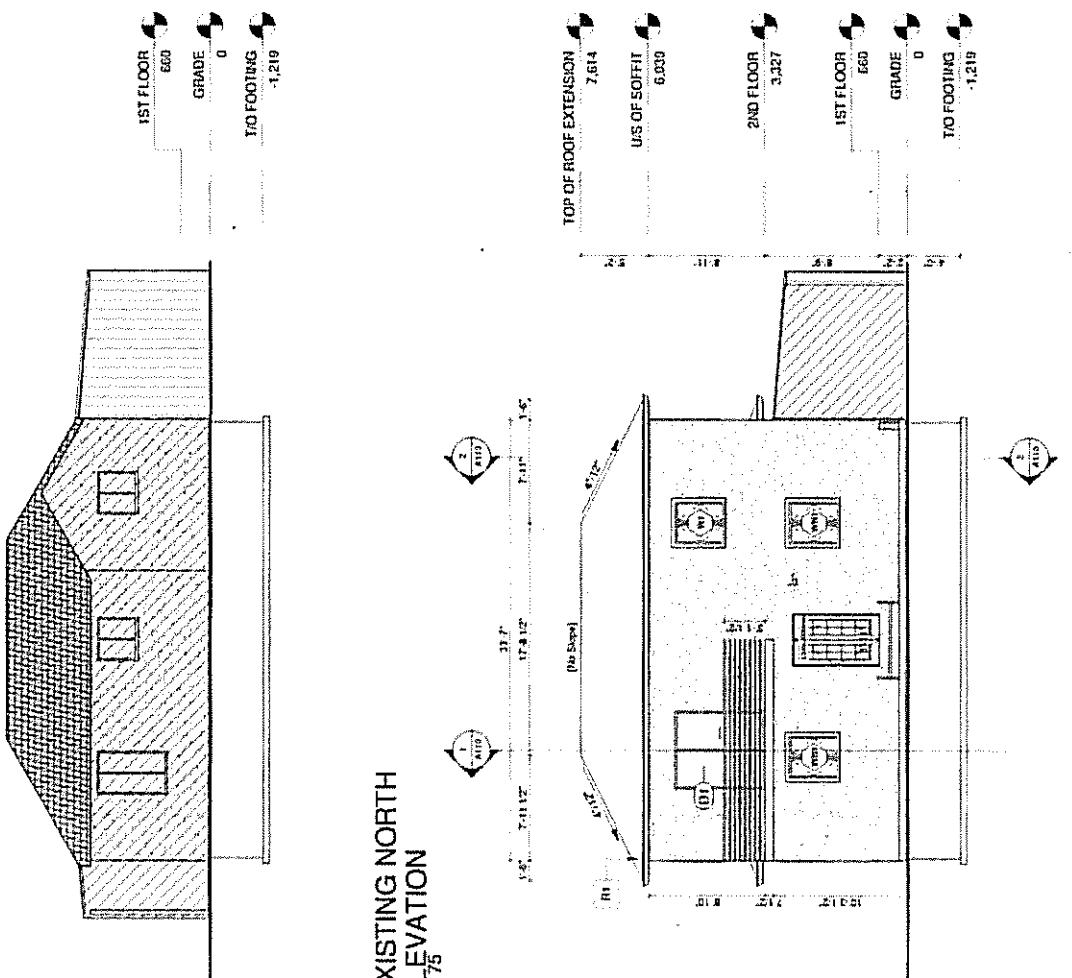

CONFUSED NORAH
ELEVATION
1:75


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Drawn by
A108




TRM.
Engineers Inc.

TMV Engineers Inc.
Building, Civil, Structural
and General Services
Engineering and Consulting

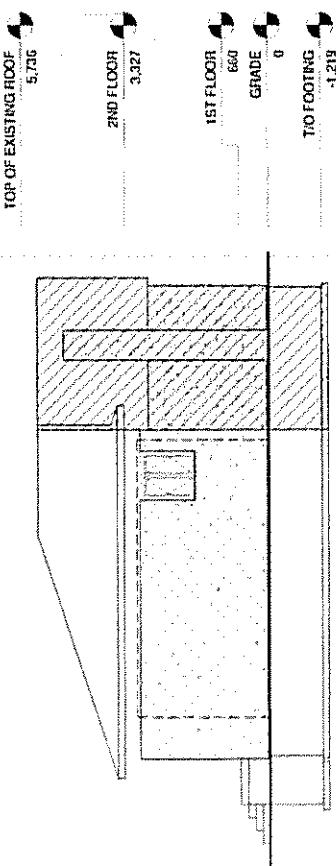

EXISTING EAST
ELEVATION
2 1:75

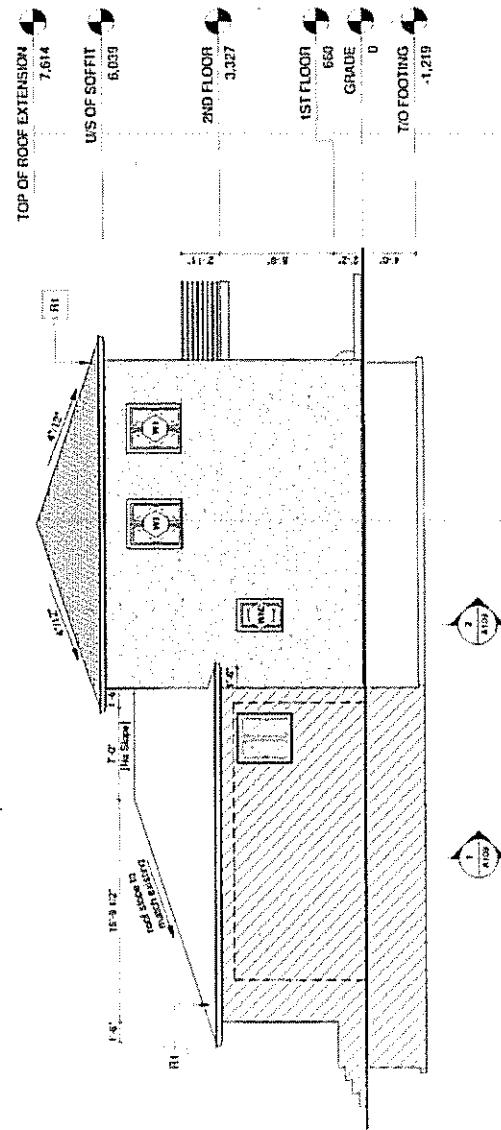

PROPOSED EAST
ELEVATION
1:75



Architectural Services
Furniture

Drawn Existing/
Proposed East
Elevation
Drawn SP
Scale 1:75
Drawn by
1.219


Date 10/10/2012

Rev. 1

Page 1

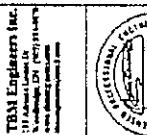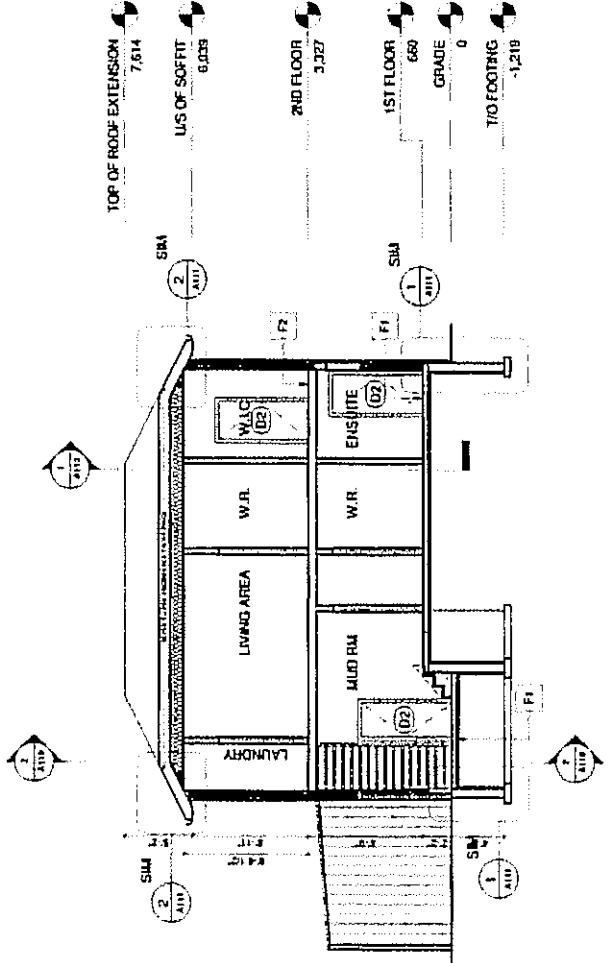

SECTIONAL ELEVATION	1:50
Architectural Services	Exterior Wall
Structural Services	Roofing System
Building Sections	Doors & Stairs
1:50 Scale	Electrical
1:50 Scale	Plumbing
1:50 Scale	Heating

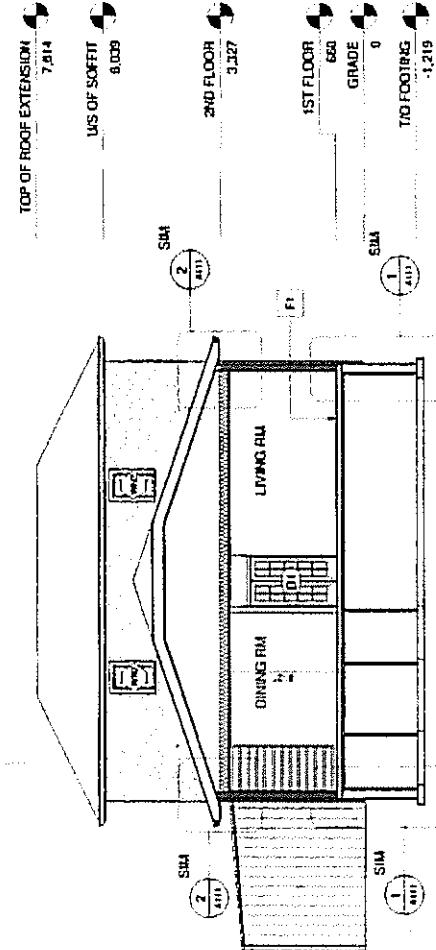

A109



IBM Engineers Inc.




PIEKS

סוכנות
הבראה
הבראה
הבראה

卷之三

卷之三

A110

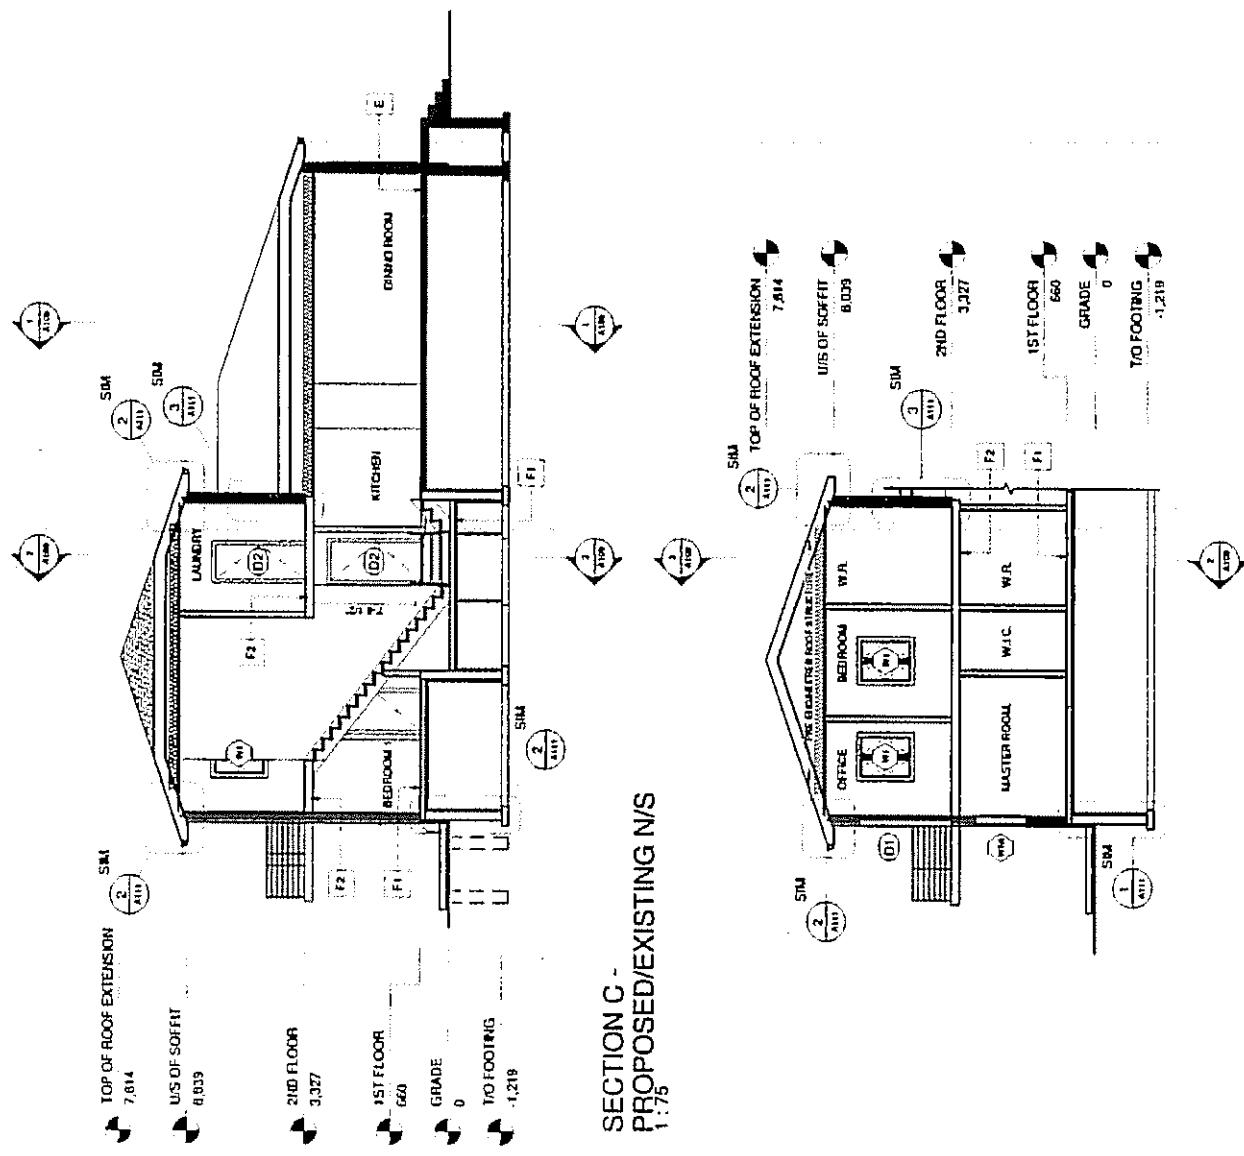

**SECTION C -
PROPOSED/EXISTING N/S
2 1:75**



TBAI Explorer loc.




PIEKS

THE JEWISH CHURCH


6745

E

111

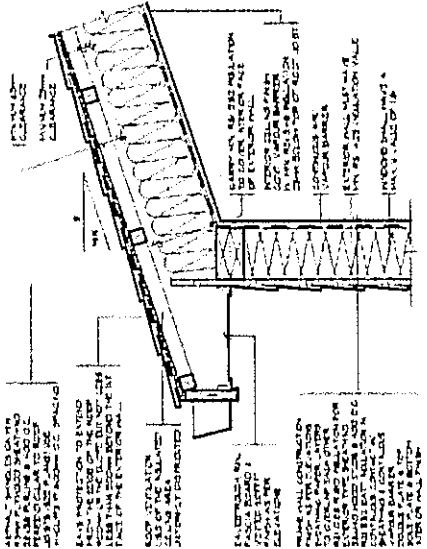

SOFFIT DETAIL

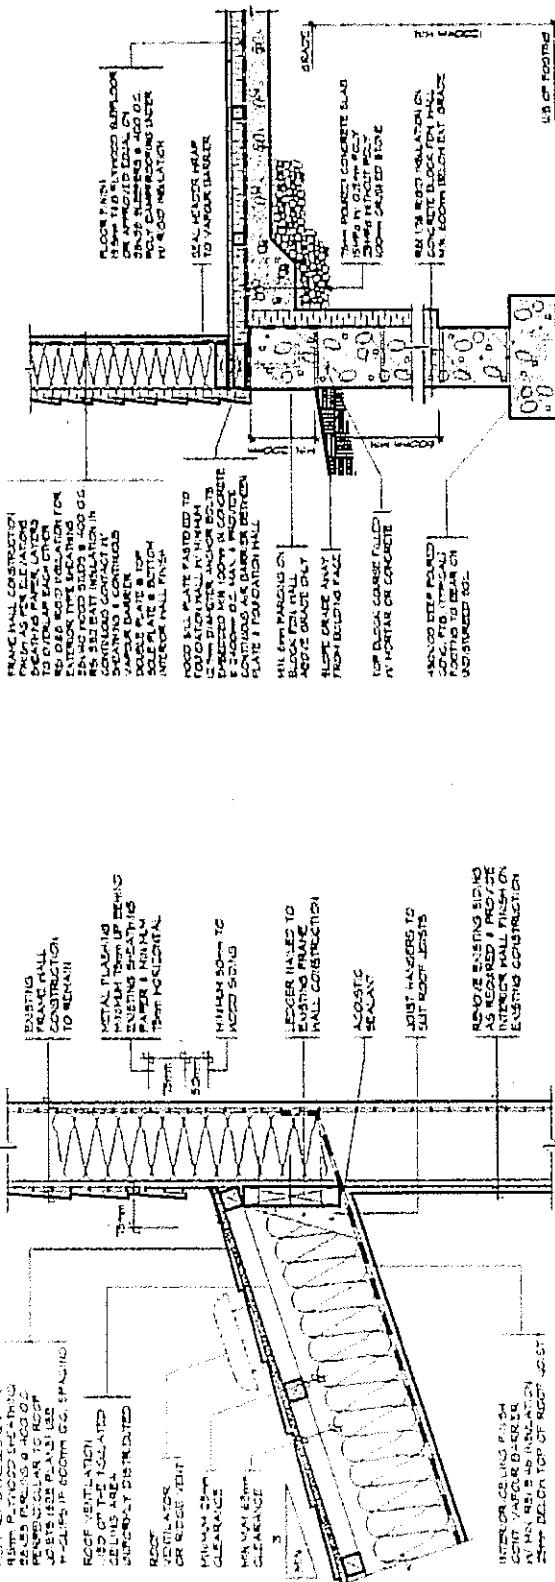

FOOTING DETAIL

ROOF CONNECTION DETAIL

